


85m2 OF ROOF AREA
TO RW TANK

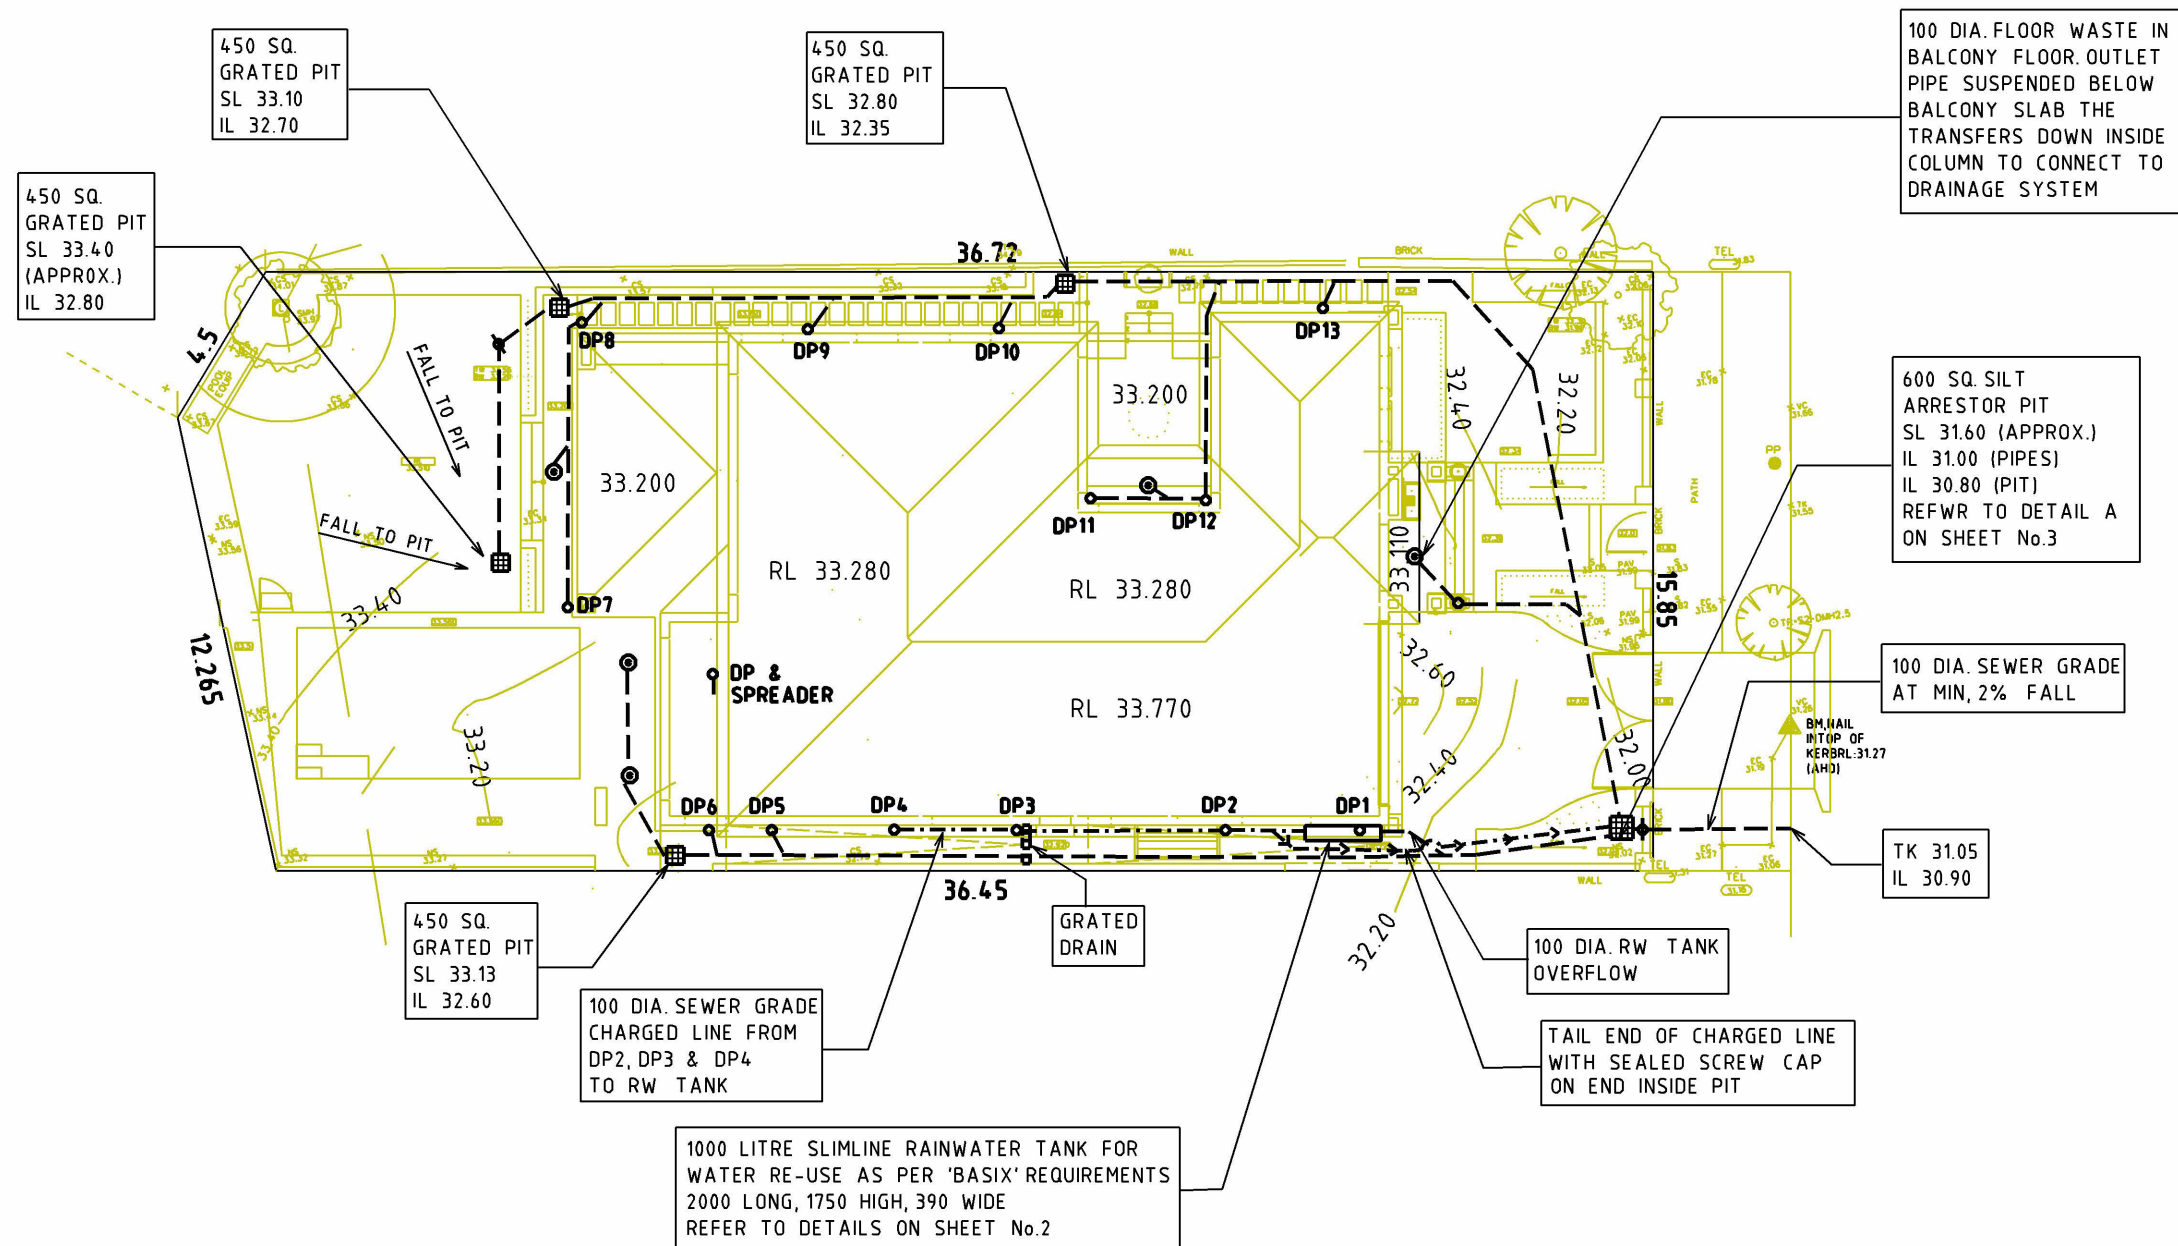

COLLINGWOOD AVENUE

DRAINAGE PLAN







SCALE 1:200

- | | |
|----------|---|
| --- | GRAVITY LINES |
| -.-.-.-. | 100 DIA. CHARGED SEWER GRADE TO RW TANK |
| ⊙ | INDICATES 100 DIA. FLOOR WASTE (SPS BRAND) |
| φ | INDICATES VERTICAL DROP IN PIPE TO LOWER SURFACE LEVELS |

STORMWATER NOTES

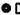1. CONTOUR PLAN SUPPLIED BY OTHERS
2. ALL STORMWATER PIPES ARE TO BE 150mm DIA. UPVC UNLESS NOTED OTHERWISE.
3. DEPTH & LOCATION OF SERVICES TO BE CONFIRMED BY BUILDER PRIOR TO COMMENCEMENT OF ANY DRAINAGE WORKS TO ENSURE NO CONFLICT ARISES.
4. THESE PLANS TO BE READ IN CONJUNCTION WITH ARCHITECTURAL PLANS.
5. FINAL DRAINAGE LINE OUTLET LEVEL & DATUM TO BE EXPOSED & CONFIRMED BY BUILDER PRIOR TO COMMENCEMENT OF WORKS. ENGINEER SHALL BE NOTIFIED OF ANY DISCREPANCIES.
6. **SYDNEY WATER TO BE ADVISED & CONSULTED WITH ANY CONSTRUCTION OVER/NEAR SEWER MAIN LINES FOR APPROPRIATE DESIGN REQUIREMENTS.**

LEGEND

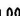- | | |
|---|----------------------------------|
|  | DOWNPIPE |
|  | DOWNPIPE SPREADER |
|  | 100 DIA FLOOR WASTE |
|  | 200x150 DEEP
GRADED BOX DRAIN |
| INV | INVERT LEVEL (PIPE / PIT) |
|  | PROPOSED SURFACE LEVEL |
| ± 0.00 | EXISTING REDUCED LEVEL |
| S.L. | SURFACE LEVEL |
| I.L. | INVERT LEVEL |
| F.F.L. | FINISHED FLOOR LEVEL |
| — X — | SEDIMENT COLLECTION BARRIER |
| — S — | SEWER |
|  | INSPECTION OPENING RISER 1/0 |

NOTES :

1. ALL DOWNPIPES ARE CHARGED AND ARE TO BE 100 DIA. SEWER GRADE FOR FULL LENGTH. UNDERGROUND PIPES TO BE 100 DIA.
2. ALL CHARGED LINES TO BE 100 SEWER GRADE TO ENSURE INTEGRITY OF CHARGE AND SOLVENT WELDED.
3. GUTTER PROTECTION SYSTEM ARE HIGHLY RECOMMENDED TO BE INSTALLED TO MINIMISE LEAVES & DEBRIS ENTERING THE SYSTEM. (BY THE OWNER)

DESIGNED & CHECKED
BY *[Signature]*

BY 
OLIVER DAHER
B.E. CIVIL
M.I.E. AUST.

A	ISSUED FOR DA			22.11.2
REV	DESCRIPTION	DESN	CHKD	DATE

J & F DESIGNS
CONSULTING HYDRAULIC, STRUCTURAL
AND CIVIL ENGINEERS
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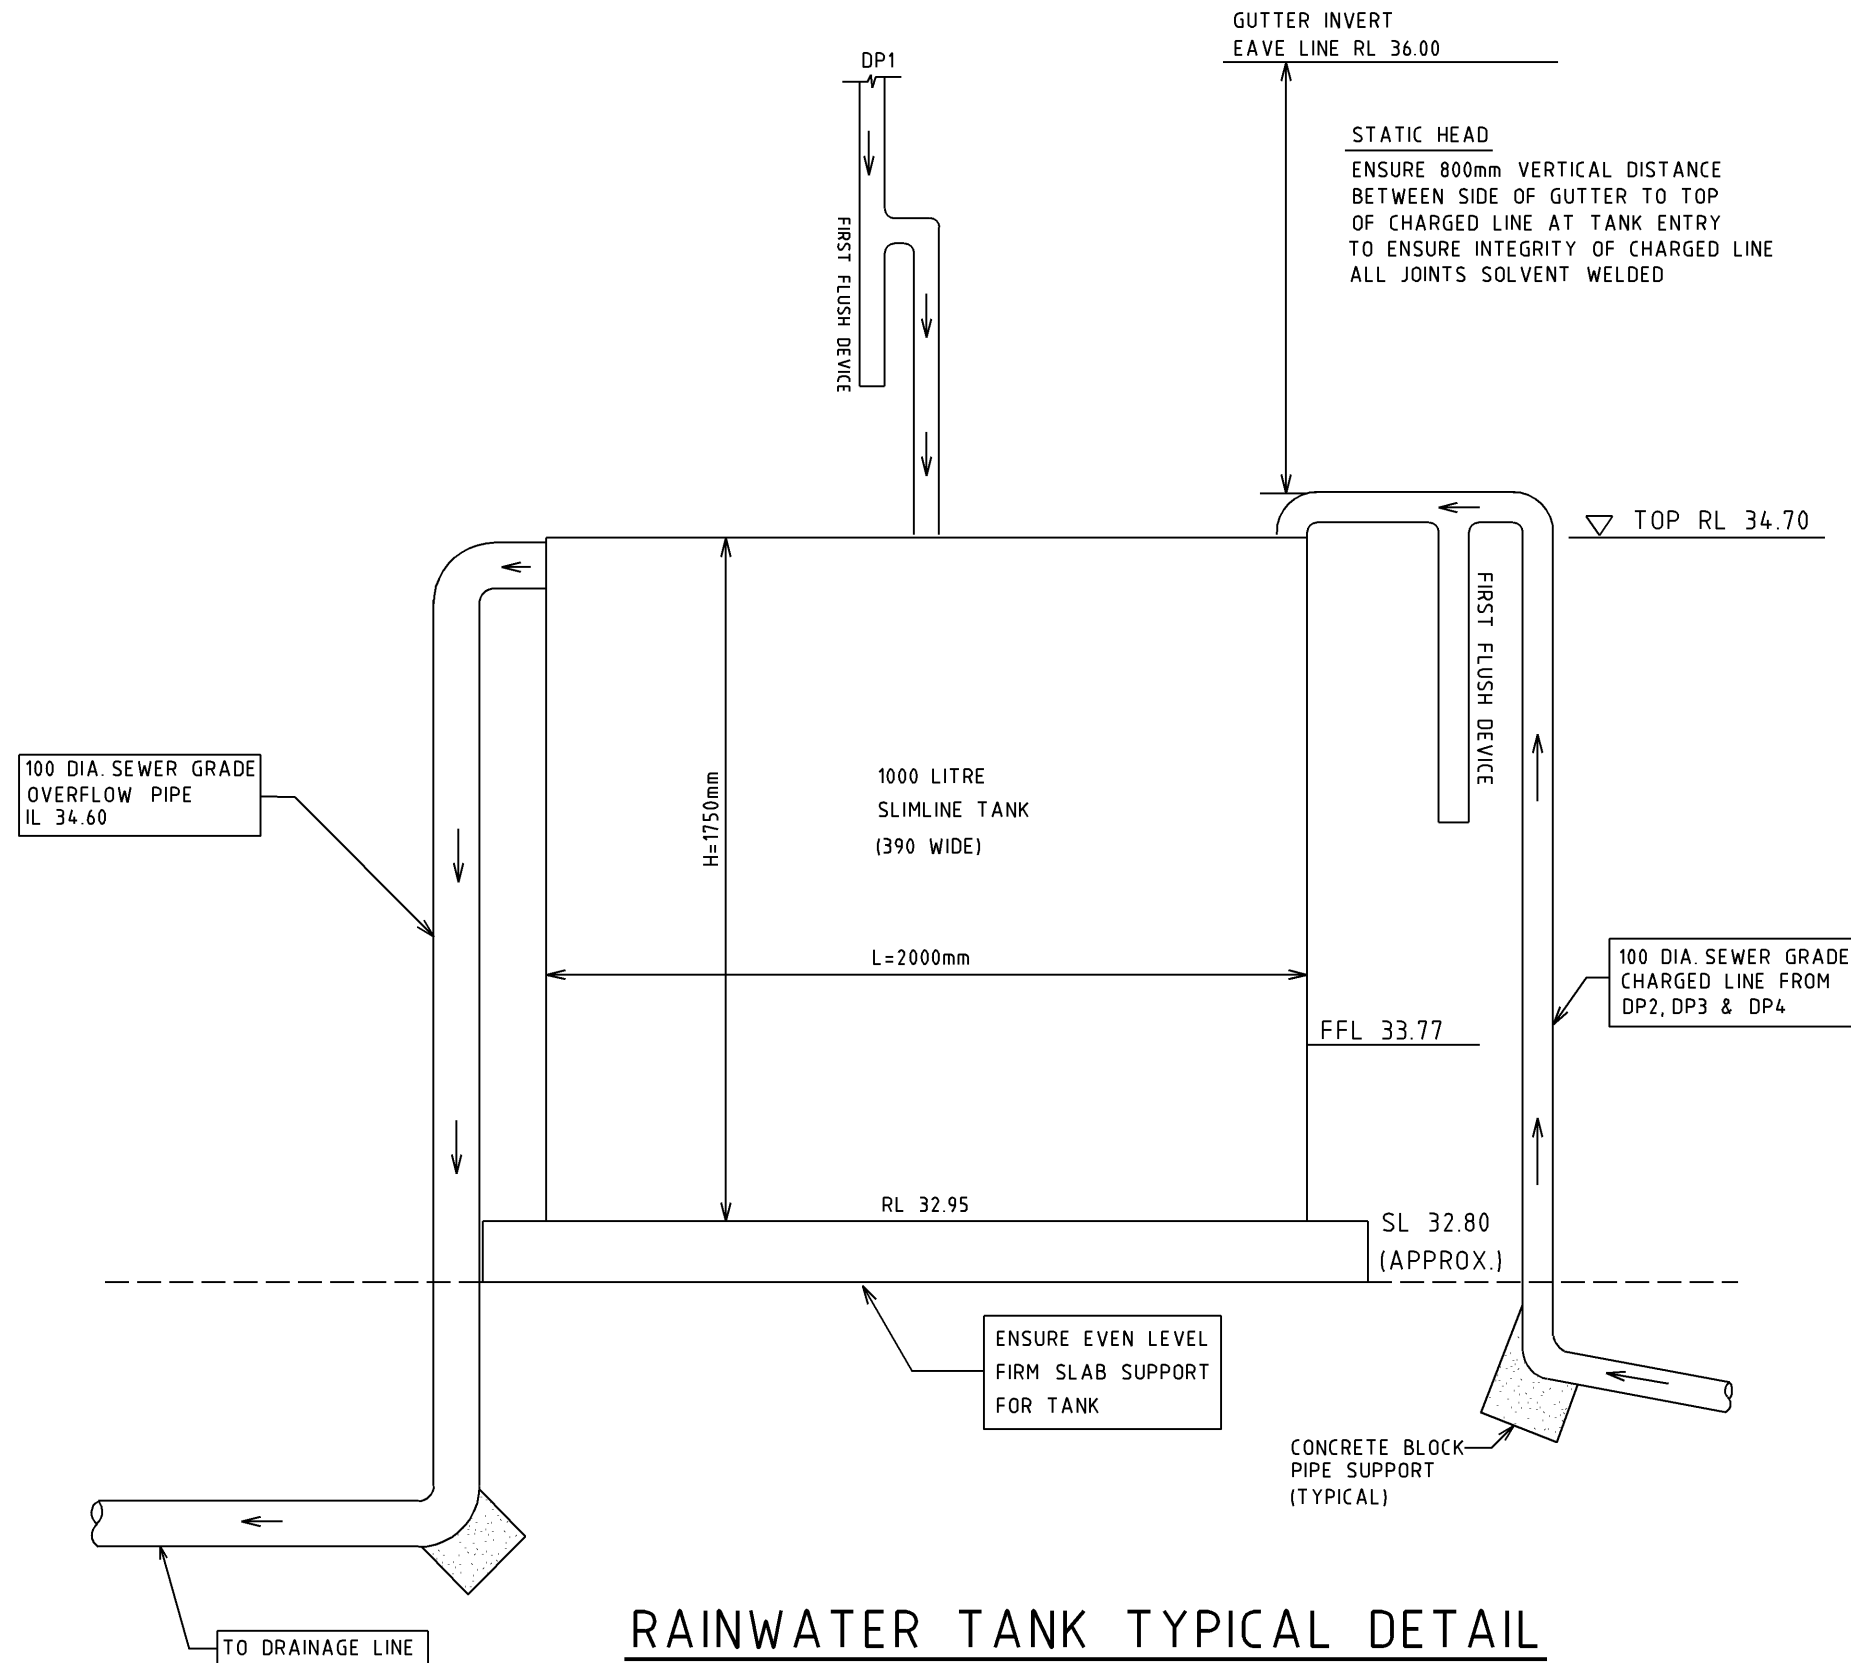
CLIENT	KURMOND HOMES
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TITLE
H/No.3 COLLINGWOOD AVENUE,
EARLWOOD

PROJECT	PROPOSED NEW RESIDENCE
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SCALE	1:200	ORIGINAL SIZE	A3	DATE	22.11.24
DRAWN	BJC	DESIGNED	OD	CHECKED	OD
DRAWING NUMBER					REVISION
5564-1 (1 of 3)					A

85m2 OF ROOF AREA
TO RW TANK



RAINWATER RE-USE SYSTEM NOTES

1. RAINWATER PLUMBING TO BE CONNECTED TO COLD WATER WASHING MACHINE TAP(S).ALL TOILETS & ALL EXTERNAL TAPS.
2. TOWNWATER CONNECTION TO RAINWATER TANK TO BE TO THE SATISFACTION OF SYDNEY WATER,THIS MAY REQUIRE PROVISION OF:
 - A. PERMANENT AIR GAP
 - B. A BACKFLOW PREVENTION DEVICE
 - C. NO DIRECT CONNECTION BETWEEN TOWN WATER SUPPLY AND THE RAIN SUPPLY.
 - D. AN APPROVED STOP VALVE AND/OR PRESSURE LIMITING VALVE AT THE RAINWATER TANK
3. PROVIDE AT LEAST ONE (1) EXTERNAL HOSE COCK ON THE TOWN WATER FOR FIRE FIGHTING.
4. PROVIDE APPROPRIATE FLOAT VALVES AND/OR SOLENOID VALVES TO CONTROL TOWN WATER SUPPLY INLET TO TANK IN ORDER TO ACHIEVE THE TOP-UP ZONE INDICATED ON THE TYPICAL DETAIL.
5. ALL PLUMBING WORKS ARE TO BE CARRIED OUT BY LICENSED PLUMBERS IN ACCORDANCE WITH AS3500.1 NATIONAL PLUMBING AND DRAINAGE CODE.
6. PRESSURE PUMP ELECTRICAL CONNECTION TO BE OUT CARRIED BY LICENSED ELECTRICIAN.
7. ONLY ROOF RUN-OFF IS TO BE DIRECTED TO THE RAINWATER TANK. SURFACE WATER INLETS ARE NOT TO BE CONNECTED.
8. PIPE MATERIALS FOR RAINWATER SUPPLY PLUMBING ARE TO BE APPROVED MATERIALS TO AS3500 PART 1 SECTION 2 AND TO BE CLEARLY AND PERMANENTLY IDENTIFIED "RAINWATER" .THIS MAY BE ACHIEVED FOR BELOW GROUND PIPES USING IDENTIFICATION TAPE (MADE IN ACCORDANCE WITH AS2648) OR FOR ABOVE GROUND PIPES BY USING ADHESIVE PIPE MARKERS (MADE IN ACCORDANCE WITH AS1345).
9. EVERY RAINWATER SUPPLY OUTLET POINT AND THE RAINWATER TANK ARE TO BE LABELLED "RAINWATER" ON A METALLIC SIGN IN ACCORDANCE WITH AS1319.
10. ALL INLETS & OUTLETS TO THE RAINWATER TANK TO HAVE SUITABLE MEASURES PROVIDED TO PREVENT MOSQUITO & VERMIN ENTRY.
11. PROVIDE ADDITIONAL WASHING MACHINE (COLD) WATER SUPPLY TAP FROM MAINS WATER FOR FUTURE OPTIONAL CHOICE BY RESIDENTS.
12. SYDNEY WATER'S APPROVAL IS REQUIRED FOR ANY TOP UP FROM DRINKING WATER SUPPLY, REGARDLESS OF TANK SIZE.
13. THE INLET FILLING RATE FROM DRINKING WATER SUPPLY IS TO BE RESTRICTED TO A MAXIMUM OF TWO(2) LITRES PER MINUTE FOR EACH HOUSE, TOWN HOUSE OR UNIT SUPPLIED FROM THE TANK.

RAINWATER TANK NOTES

1. INSTALL LEAF STRAINERS, SCREENS, STOP VALVES
CHECK VALVE, PUMPS, FLOW RESTRICTORS TO
AUSTRALIAN STANDARDS MANUFACTURERS DETAIL
AND TO SYDNEY WATER REQUIREMENTS.
2. ALL PLUMBING & ELECTRICAL TO BE COMPLETED IN
ACCORDANCE WITH THE RELEVANT AUSTRALIAN STANDARDS.

RAINWATER TANK TYPICAL DETAIL

NOT TO SCALE

DESIGNED & CHECKED
BY

BY 
OLIVER BAUER

OLIVER DAHER
B.E. CIVIL
M.I.E. AUST.

A	ISSUED FOR DA			22.11.2
REV	DESCRIPTION	DESN	CHKD	DATE

J & F DESIGNS


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PHONE/FAX 9613 4441
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enqplan@optusnet.com.au

CLIENT	KURMOND HOMES
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TITLE
H/No.3 COLLINGWOOD AVENUE,
EARLWOOD


PROJECT	PROPOSED NEW RESIDENCE
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SCALE AS SHOWN		ORIGINAL SIZE A3		DATE 22.11.24	
DRAWN BJC		DESIGNED OD	INIT	CHECKED OD	INIT
DRAWING NUMBER 5564-2					REVISION A



SILT ARRESTOR PIT DETAIL A

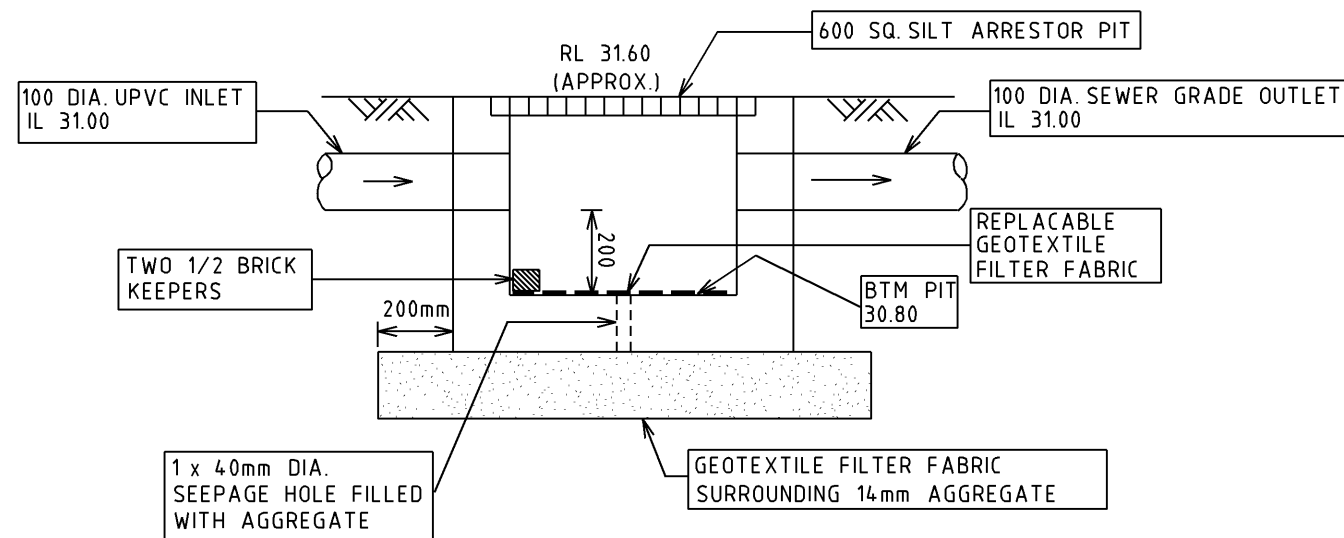
SCALE 1:20

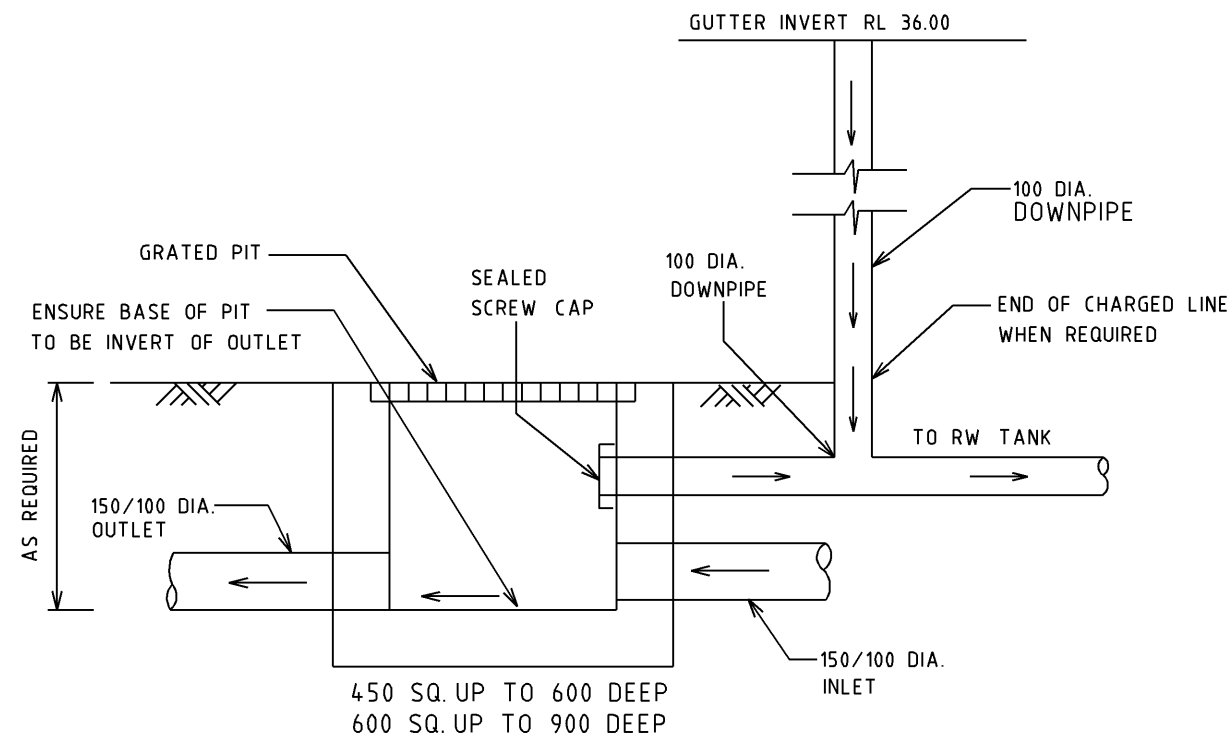

TYPICAL PIT DETAIL

(WITH TAIL END OF CHARGED LINE SHOWN)

SCALE 1:20

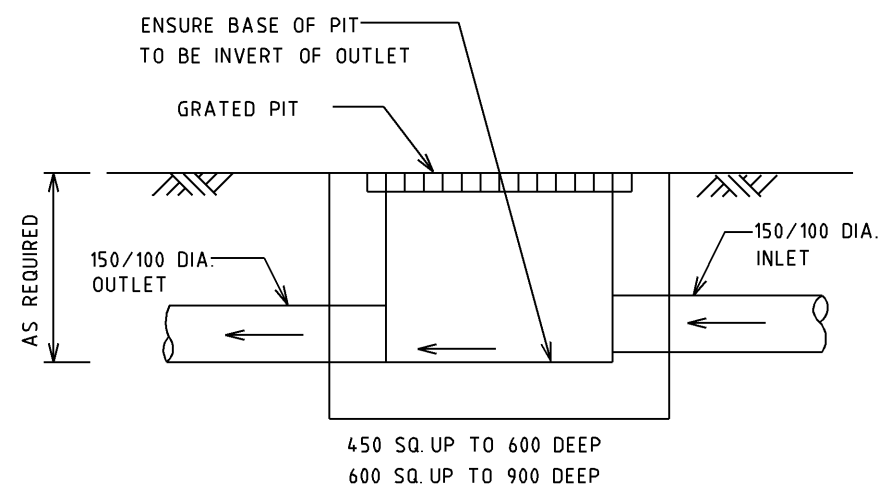

TYPICAL PIT DETAIL

SCALE 1:20

DESIGNED & CHECKED
BY

Oliver Daher
OLIVER DAHER
B.E. CIVIL
M.I.E. AUST.

REV	DESCRIPTION	DESN	CHKD	DATE
A	ISSUED FOR DA			22.11.24

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CLIENT
KURMOND HOMES

TITLE
H/No.3 COLLINGWOOD AVENUE,
EARLWOOD

PROJECT
PROPOSED NEW RESIDENCE

SCALE 1:200		ORIGINAL SIZE A3		DATE 22.11.24	
DRAWN BJC		DESIGNED OD	INIT	CHECKED OD	INT
DRAWING NUMBER 5564-3					REVISION A